

2)

 All lumber to be No. 2 Spruce or better.
 All lumber exposed to weather conditions must be pressure treated, painted or stained

General Notes:

- Technical Design Data for all Pre-engineered Cottage Style) at Building Permit Application Pre-engineered framing component types (ie Provide Technical Design Data for all other the Framing Inspection for gable end roofs. Framing Components must be submitted at
- 3) Mininum Bearing of all joists & double lintels to be min. 1 1/2". Minimum Bearing of all Beams & Lintels with more than 2 ply to be min. 3 1/2".
- Floor drains within Detached Garages shall not be connected to Municipal Sewer Services. Moisture Barrier is required between all lumber which is in direct contact with the ground. in direct contact with or within 6" of concrete

5

4

All Concrete for Floor Slab to be 32 Mpa and shall have air entrainment of 5% to 8%. Discharge to a proper drainage swale or ditch

6)

7) Detached Garages of less than 55 m² (592 ft² provided the garage is not of masonry or height may be supported on wood mud sills masonry veneer construction. floor area and not more than 1 storey in

etached Garage

14,

_ 3 - 2 x 8's _ 3 - 2 x 10's _ 3 - 2 x 12's _ W6 x 15 steel beam

Garage Door Width

Lintel Size

16' -----Max. 16'-1" supported length

It is the Contractor's responsibilty to ensure that all construction conforms to the requirements of

the Ontario Building Code latest addition.

necessarily comment on all areas of construction Notations made on these drawings are for your information and assistance only and do not

BUILDING SERVICES www.greatersudbury.ca


Slab on Grade with Perimeter Footing FLOOR LAYOUT

SCALE: NTS

DRAWN BY: E.P

DATE: 03/2020 (REV.)

/- I (soc) SHEET

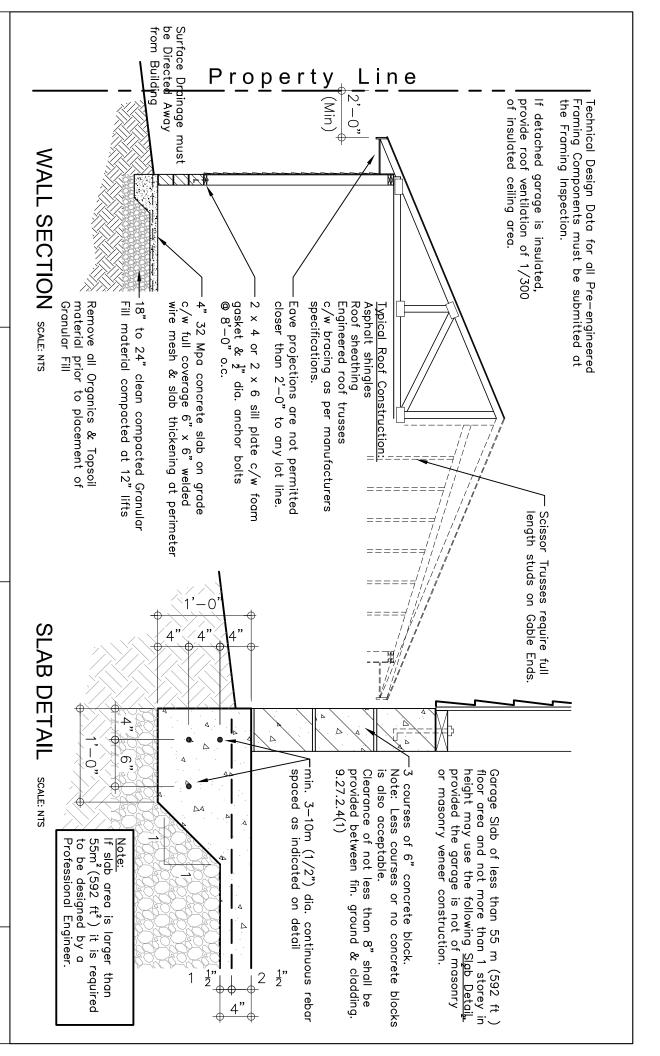

NOTE:

It is the Contractor's responsibilty to ensure that all construction conforms to the requirements of the Ontario Building Code latest addition.

Notations made on these drawings are for your information and assistance only and do not necessarily comment on all areas of construction



Detached Garage


Slab on Grade with Perimeter Footing

SECTION and DETAIL SCALE: NTS

DRAWN BY: E.P.

DATE: 03/2020 (REV.)

A-2 (SOG)

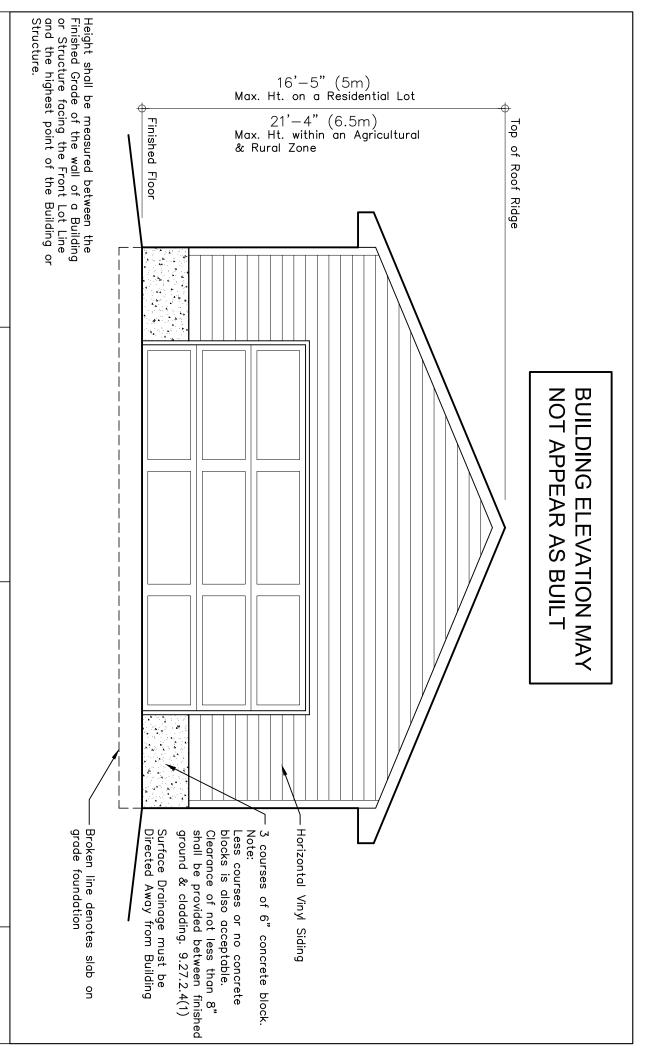

the Ontario Building Code latest addition. Notations made on these drawings are for your information and assistance only and do not It is the Contractor's responsibilty to ensure that all construction conforms to the requirements of necessarily comment on all areas of construction



etached Garage)

Slab on Grade with Perimeter Footing FRONT ELEVATION


SCALE: NTS

DRAWN BY: E.P.

DATE: 03/2020

A-3_(soc)

NOT APPEAR AS BUILT **BUILDING ELEVATION MAY**

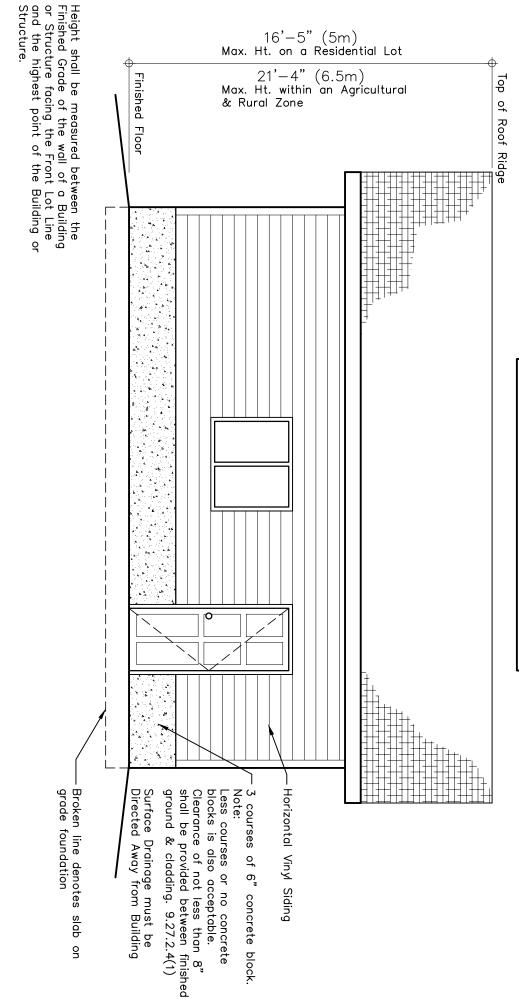

the Ontario Building Code latest addition. Notations made on these drawings are for your information and assistance only and do not It is the Contractor's responsibilty to ensure that all construction conforms to the requirements of necessarily comment on all areas of construction



etached Garage

Slab on Grade with Perimeter Footing SIDE ELEVATION

SCALE: NTS

DATE: 03/2020 (REV.) DRAWN BY: E.P.